

TOTAL SITE AREA: ± 7.06 AC

> R06200-003-031-000 R06200-003-035-000

> > SKF ILM, LLC

21 (3BR) UNITS

12,865 S.F. * 8% = 1,029 S.F.

PROPERTY LINE

LIMITS OF DISTURBANCE

Scale: 1"=50'

STORMWATER MANAGEMENT PLAN

APPROVED

CITY OF WILMINGTON

ENGINEERING DEPARTMENT

_ PERMIT # _

DATE_

-- CONTOUR

---- WETLAND BUFFER

TEMPORARY SILT FENCE TREE PROTECTION FENCE

TREES TO BE REMOVED

1,082 S.F.

R06200-003-038-000 R06200-003-039-000 R06200-003-042-000

CURRENT ZONING: R-15 (CLUSTER SUBDIVISION) PROJECT ADDRESS: 6415 GREENVILLE LOOP RD. WILMINGTON, NC 28409

5929 MARKET ST. WILMINGTON, NC 28405

CAMA LAND USE CLASSIFICATION: WATERSHED RESOURCE PROTECTION AREA

BUILDING SIZE: 1,750 S.F. **BUILDING HEIGHT:** 35' MAX.

BUILDING SETBACKS: REQUIRED: 25' PERIMETER PROPOSED: 25' REQUIRED: 10' BETWEEN STRUCTURES PROPOSED: 13.5' MIN.

BUILDING COVERAGE: PROPOSED COVERAGE 36,750 S.F. ÷ 307,334 S.F. = 12.0%

TOTAL IMPERVIOUS BEFORE & AFTER DEVELOPMENT: BEFORE DEVELOPMENT: o S.F.

> AFTER DEVELOPMENT: BUILDINGS 36,750 S.F. CONCRETE 7,033 S.F. **ASPHALT** 23,586 S.F. FUTURE 6,391 S.F. 73,760 S.F. (24.0%)

OFFSITE IMPERVIOUS AREAS:

CONCRETE DRIVEWAY APRON 251 S.F.

PARKING REQUIRED: 48 SPACES (2 H.C.) 2.25 SPACES / 3BR UNIT @ 21 UNITS =

PARKING PROVIDED: 52 SPACES (3 H.C.)

BICYCLE PARKING REQUIRED: (MIN. 5 PER 25-125 VEHICLE SPACES) PROVIDED 5 BICYCLE RACK SPACES

PARKING LOT INTERIOR LANDSCAPING

REQUIRED

OPEN SPACE REQUIREMENT: (40% of site area)

7.06 AC X 0.40 =2.82 AC PROVIDED 3.10 AC

WATER AND SEWER CAPACITY NEEDS:

WATER (CURRENT USE):

SEWER (CURRENT USE): o GPD

WATER (PROPOSED USE):

21 UNITS @ 400 GPD = 8,400 GPD SEWER (PROPOSED USE:) 21 UNITS @ 360 GPD = 7,560 GPD

1. TREE PROTECTION SIGNAGE SHALL BE ADDED ALONG THE LIMITS OF DISTURBANCE EVERY 100' TO PROTECT TREES ADJACENT TO THE


DEMOLITION REMOVAL/P

VICINITY MAP

(NOT TO SCALE

REVISIONS

EER

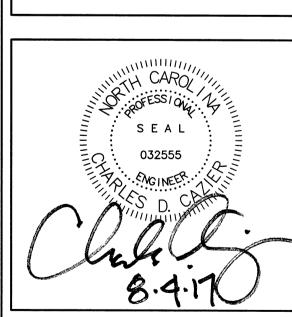



CLIENT INFORMATION:

SKF ILM, LLC 5929 MARKET STREET WILMINGTON, NC 28405 (910) 619-6858

DRAWN:	BPD	SHEET SIZE:	24x36
CHECKED:	CDC	DATE:	8/4/2017
APPROVED:	CDC	SCALE:	1" = 50'
PROJECT NUMBER:		2016-039	

DRAWING NUMBER: C-1

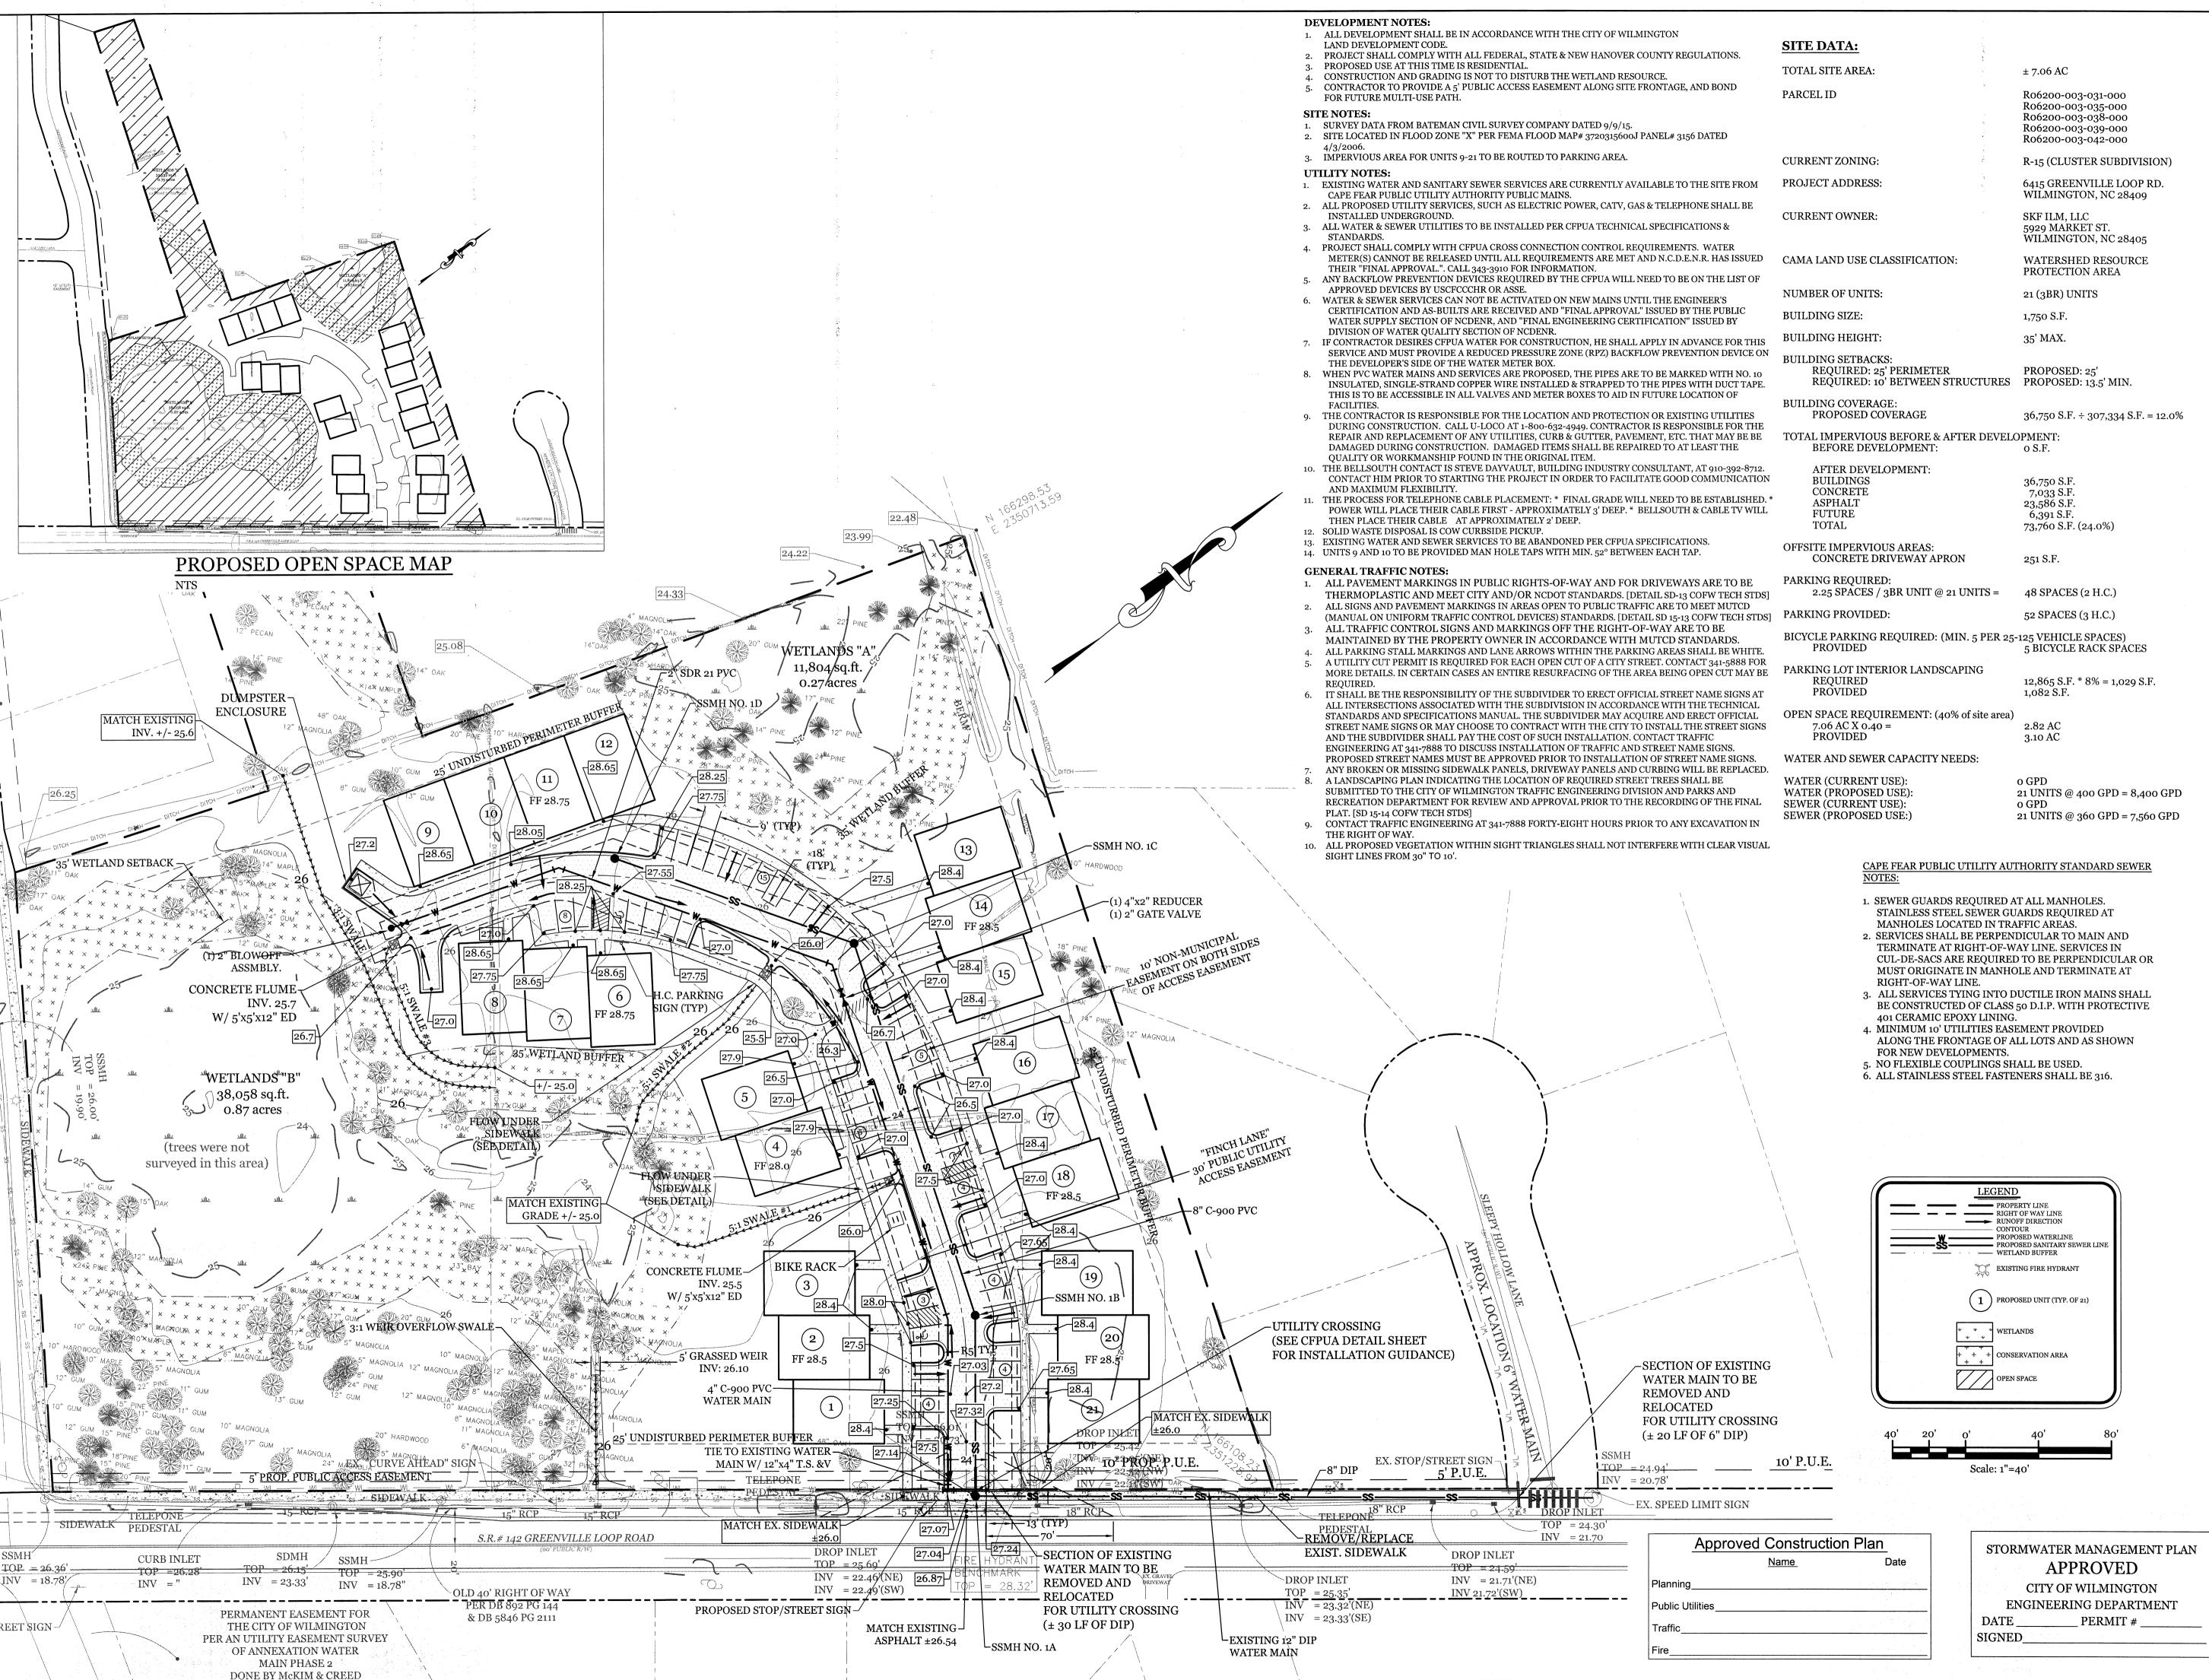

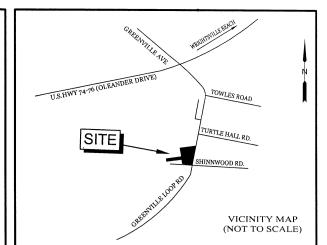

REVISIONS

BPD | SHEET SIZE: CHECKED: CDC DATE: 8/4/2017 APPROVED: CDC | SCALE: PROJECT NUMBER: 2016-039

SEAL

CLIENT INFORMATION:


5929 MARKET STREET

WILMINGTON, NC 28405

SKF ILM, LLC

(910) 619-6858

DRAWING NUMBER:

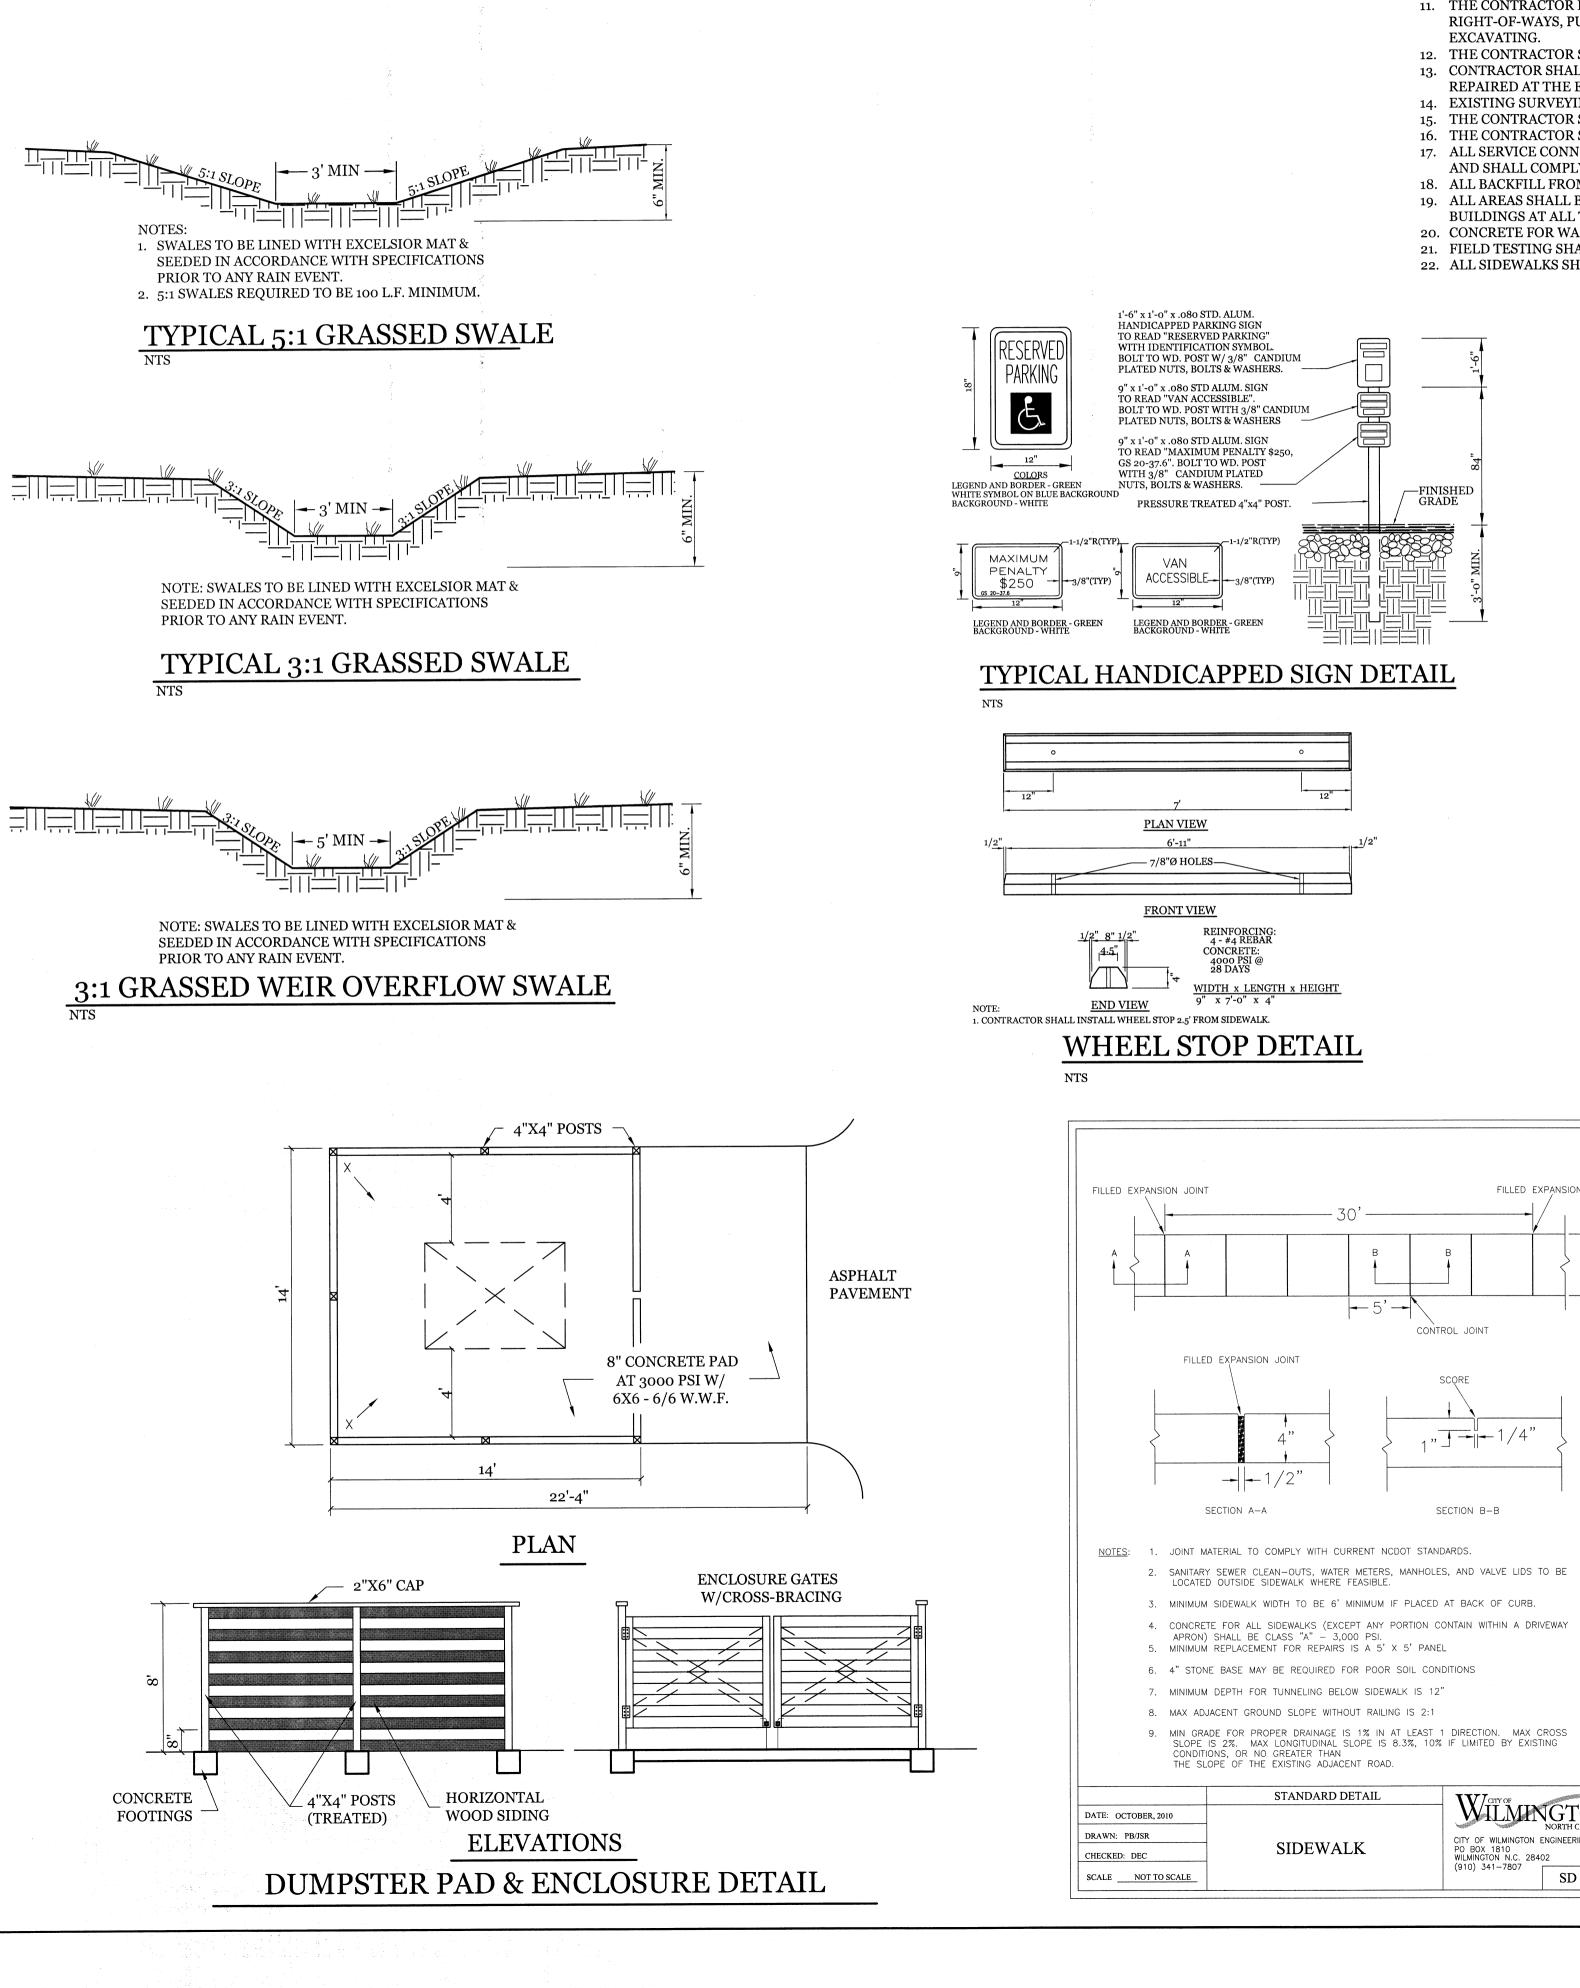

REINFORCING 4 - #4 REBAR

- 1

STANDARD DETAIL

SIDEWALK


1/4"

CITY OF WILMINGTON ENGINEERING

SD 3-10


PO BOX 1810 WILMINGTON N.C. 28402 (910) 341-7807


SECTION B-B

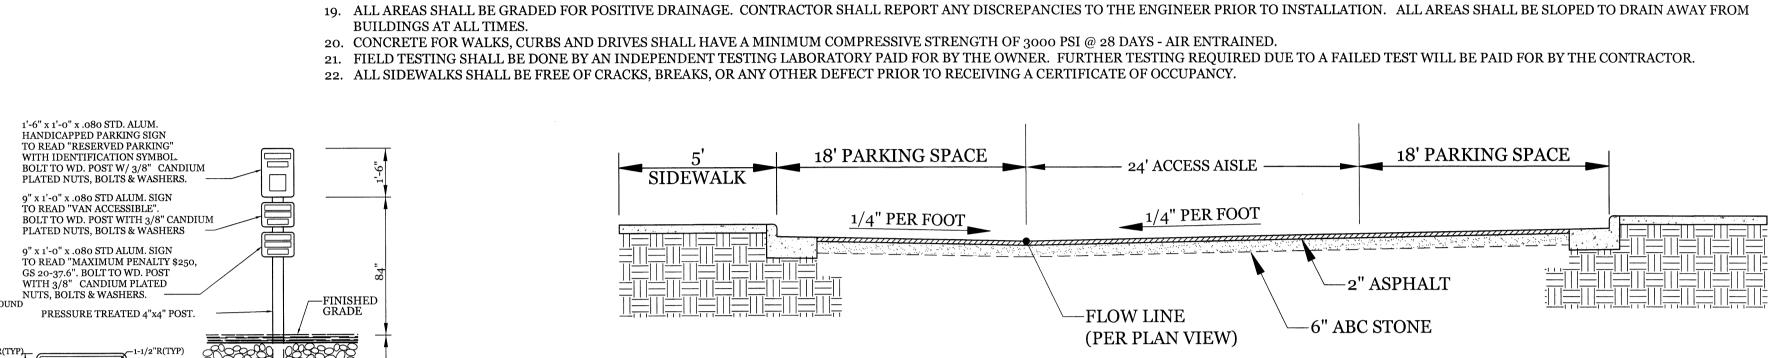

ACCESS DRIVE CROSS SECTION (SUPERELEVATED)

INSET

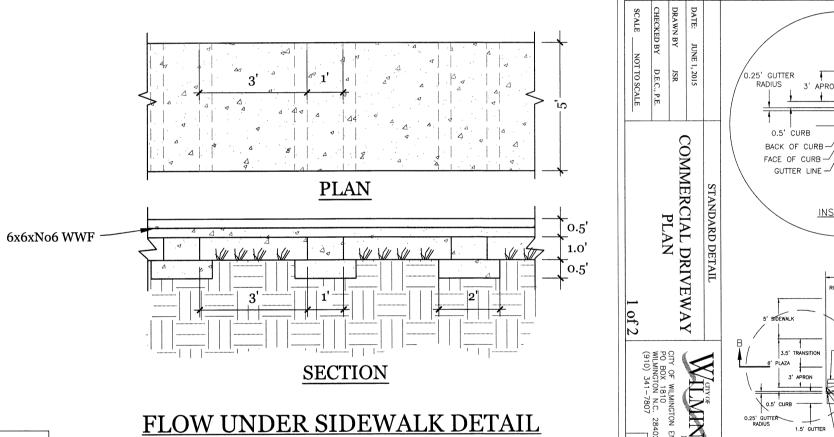

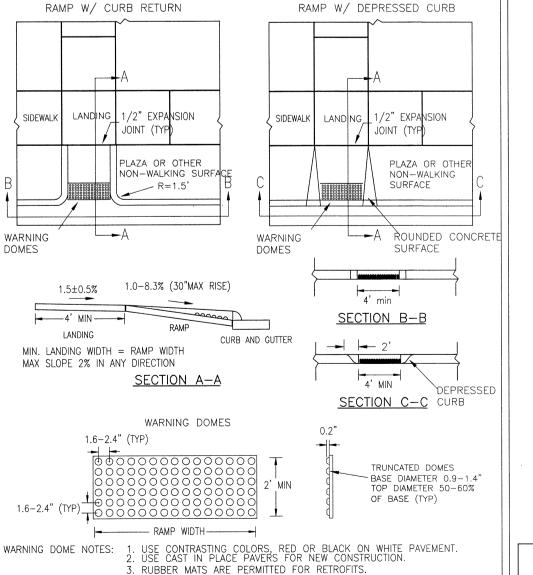

4. LANDING AND RAMP WIDTH MAY BE REDUCED TO 3' WHERE SPACE

CITY OF WILMINGTON ENGINEERING

SD3-08

IS LIMITED AND DESIGN IS APPROVED BY THE CITY ENGINEER.

STANDARD DETAIL

PERPENDICULAR CURB


RAMP

ADJACENT TO PLAZA

DATE: DECEMBER, 2010

DRAWN: PB/JSR

CHECKED: DEC

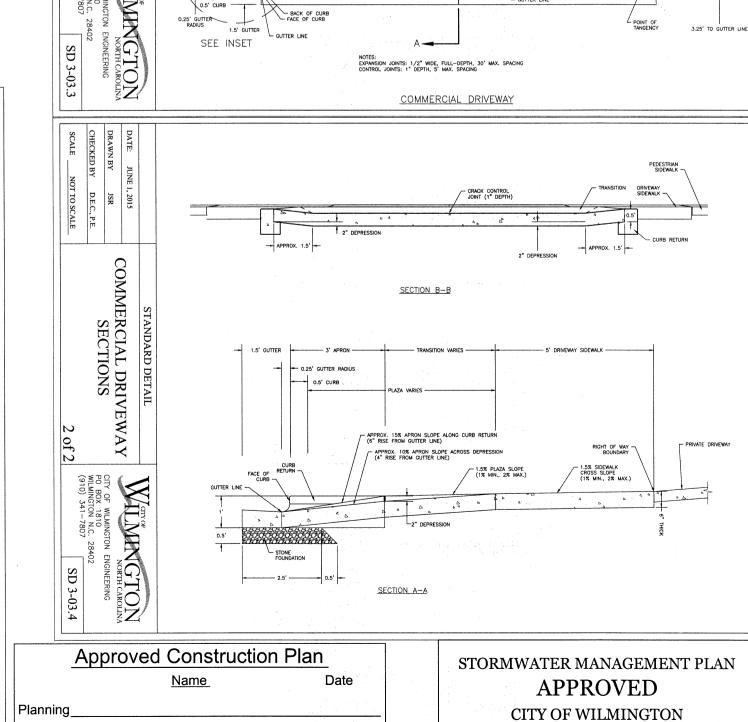

PRIVATE DRIVEWAY

3' MINIMUM EXTENS


ENGINEERING DEPARTMENT

__ PERMIT # _


DATE _

SIGNED_

3' TO FACE OF CURB

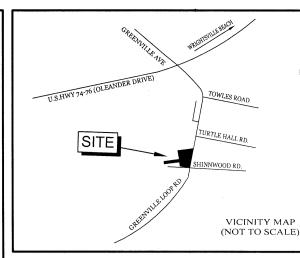

REVISIONS

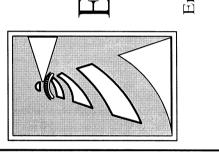


SEAL 032555


CLIENT INFORMATION:

SKF ILM, LLC 5929 MARKET STREET WILMINGTON, NC 28405 (910) 619-6858

BPD | SHEET SIZE: DRAWN: CDC DATE: CHECKED: 8/4/2017 CDC | SCALE: APPROVED: PROJECT NUMBER: 2016-039

DRAWING NUMBER:

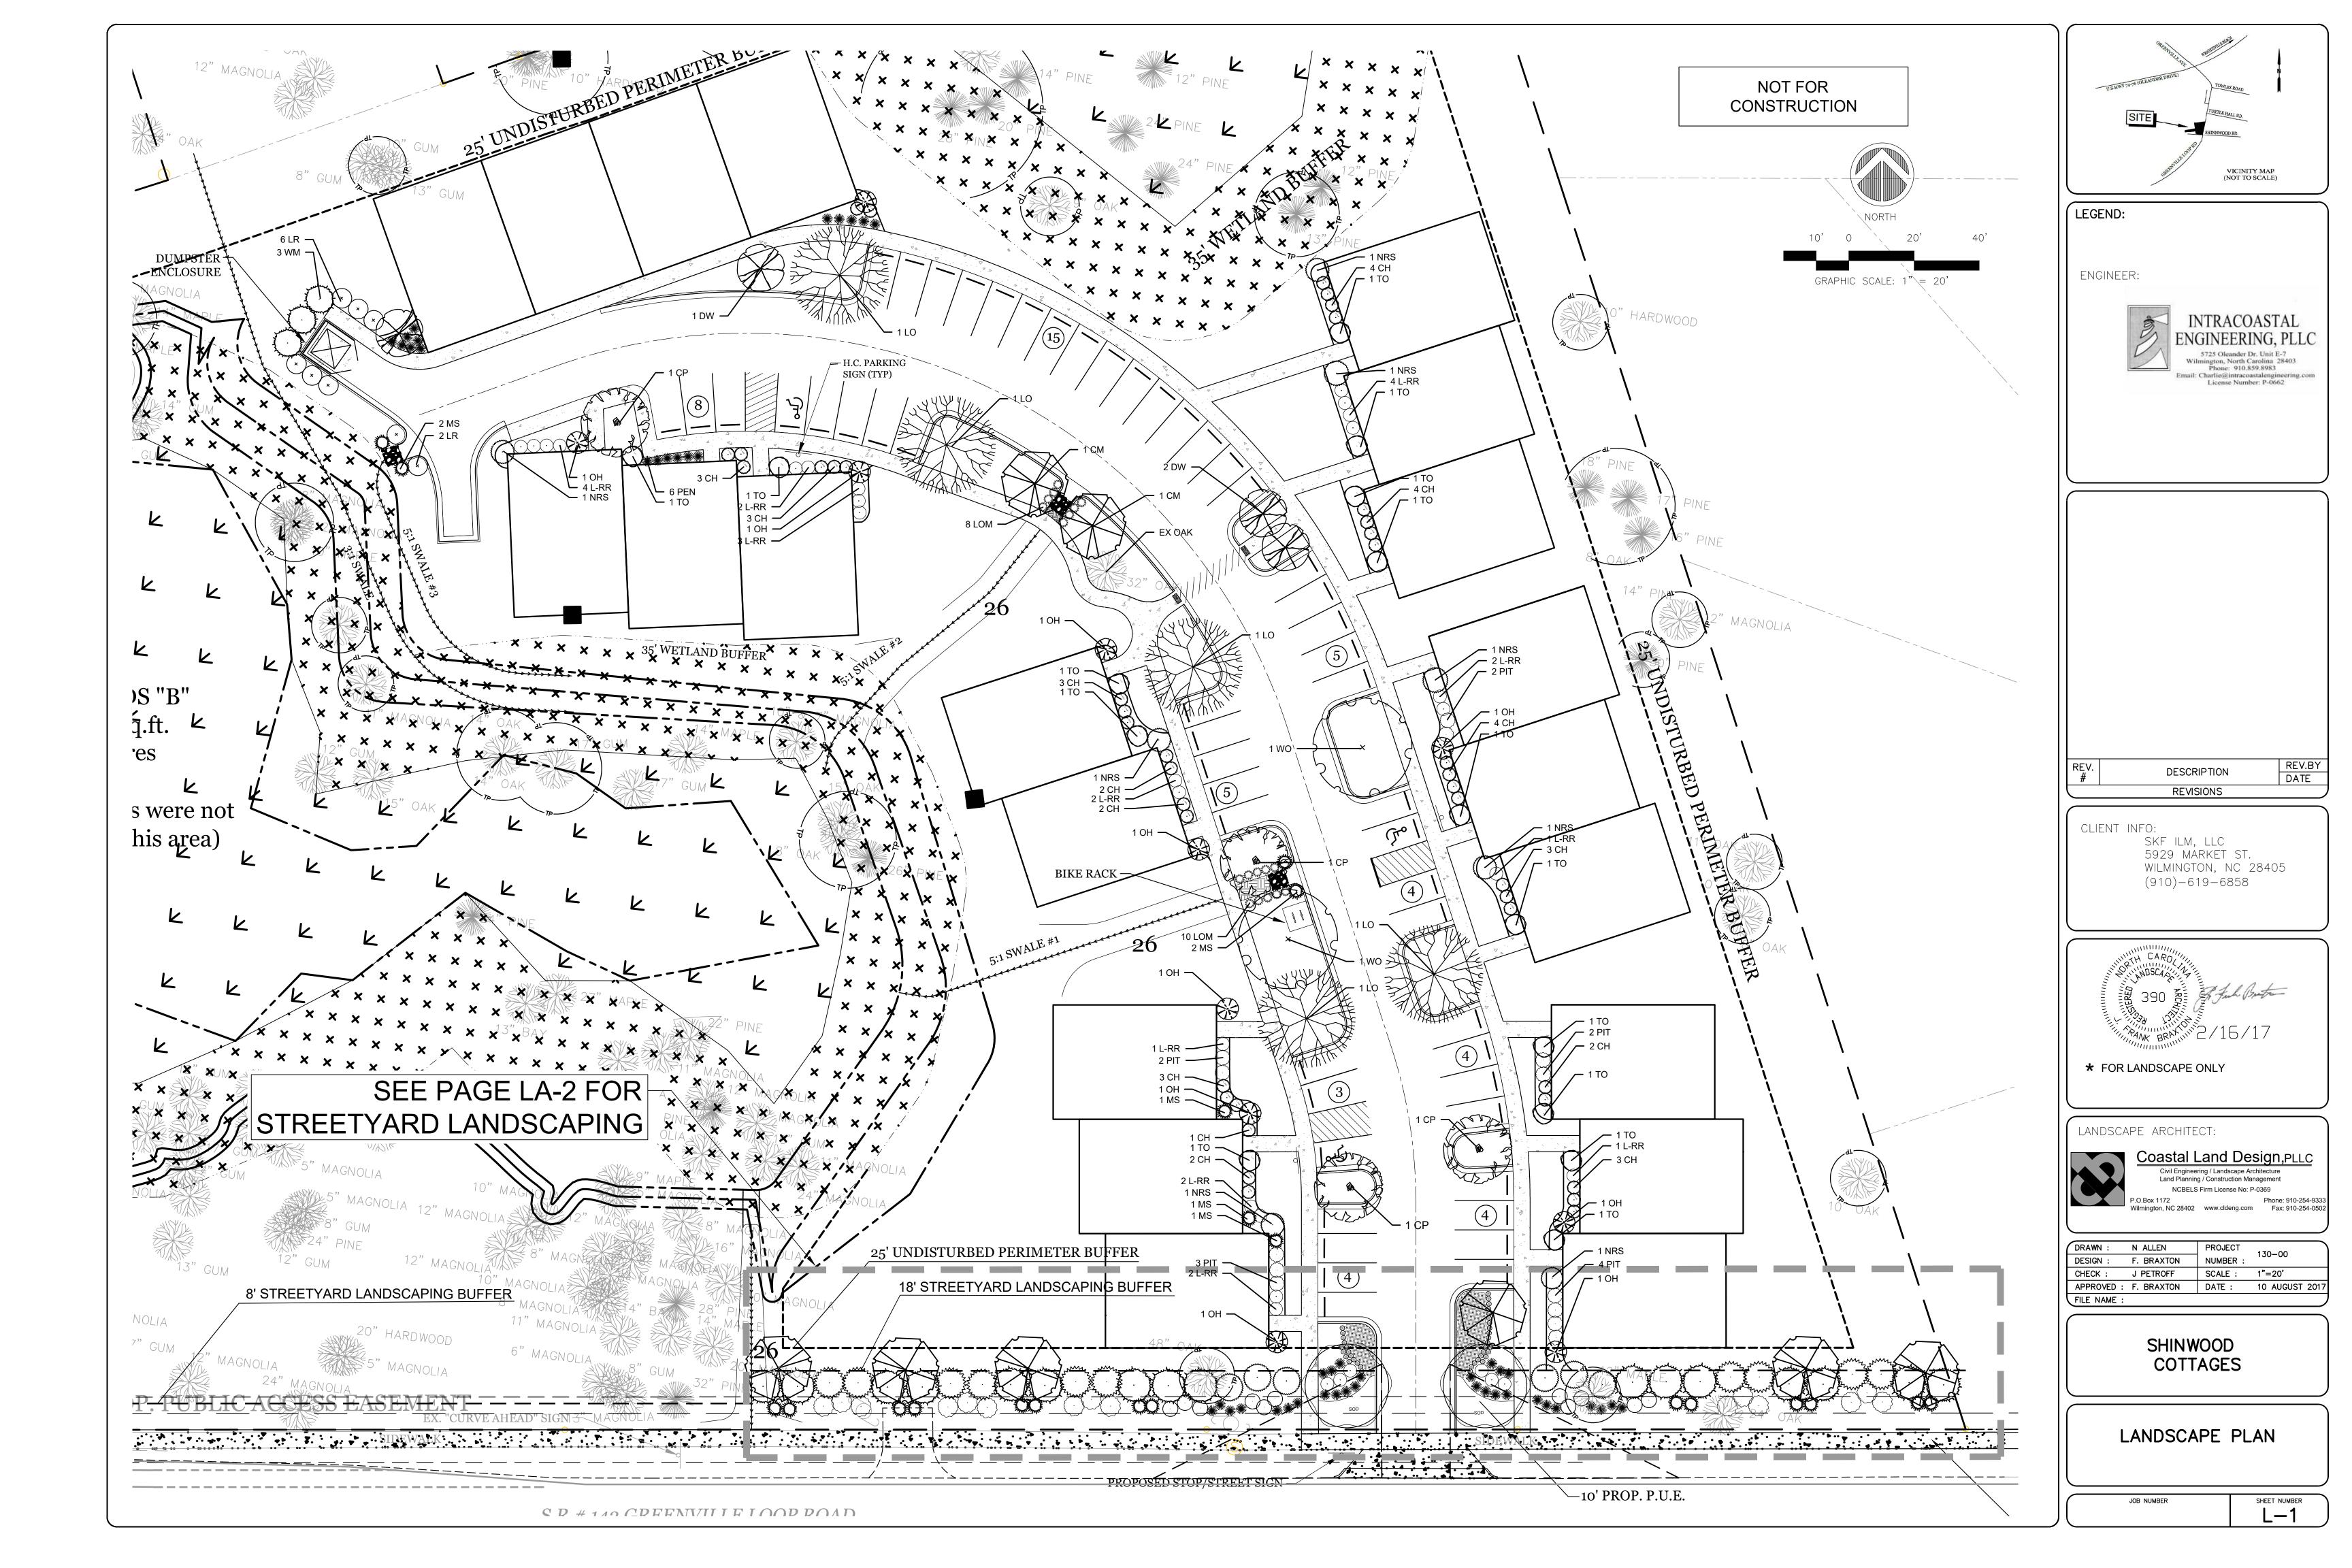

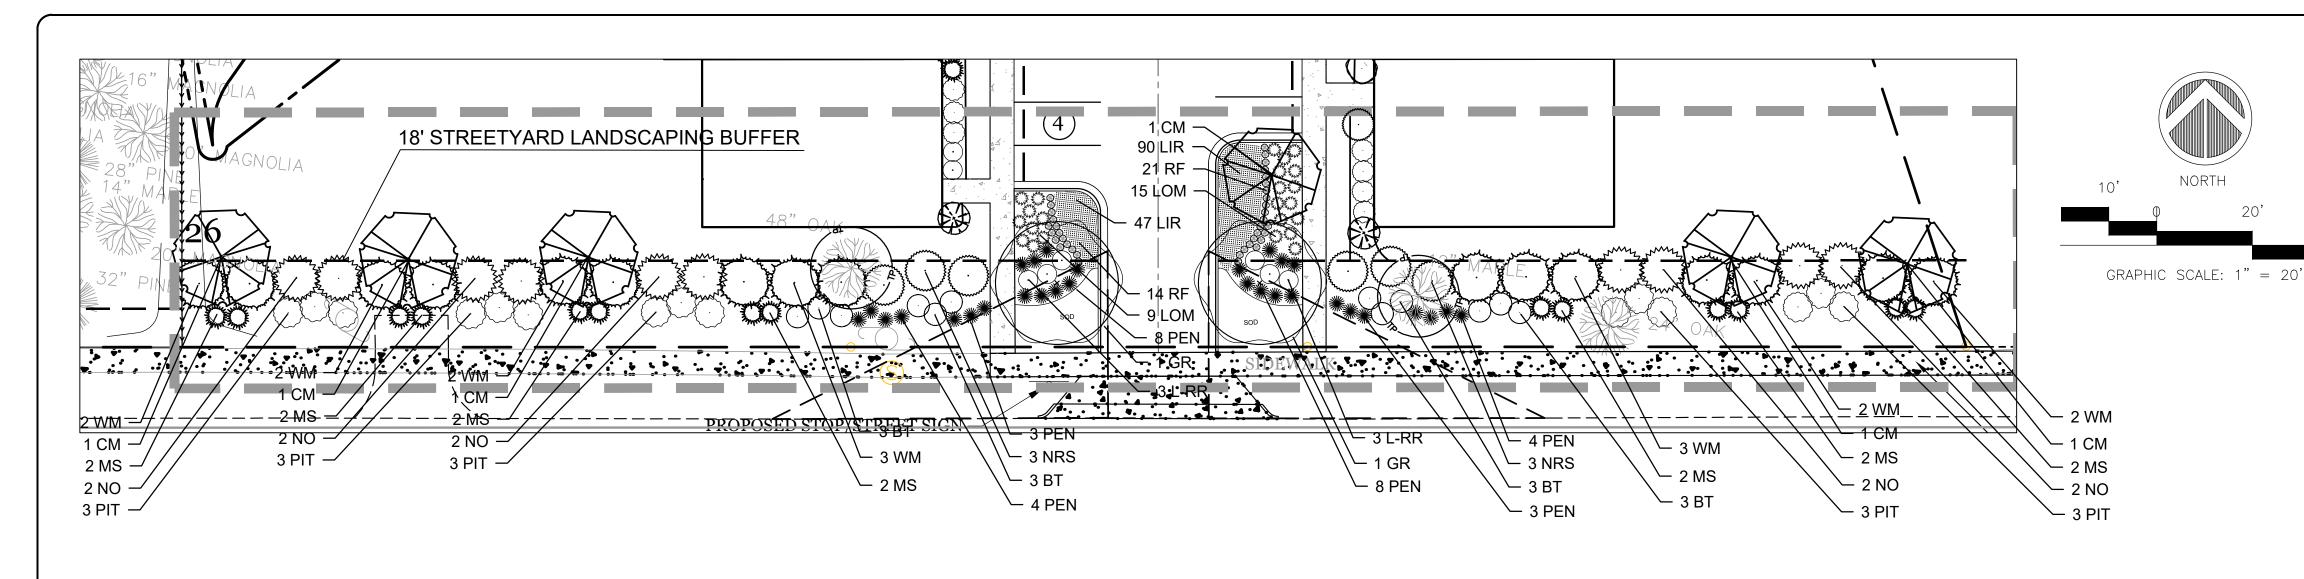

DTANICAL NAME	COMMON NAME	CAL.	HT.	REMARKS	QUAN.	SYMBO
RGE SHADE TREES						
JERCUS VIRGINIANA	LIVE OAK	2.5"		B&B	5	LO
ISTACIA CHINENSIS	CHINESE PISTACHE	2.5″		B&B	4	СР
OELREUTERIA PANICULATA	GOLDEN RAIN TREE	2.5″		B&B	2	GR
UERCUS PHELLOS	WILLOW OAK	2.5″		B&B	2	WO
MALL SHADE TREES						
AGERSTROEMIA INDICA X FAURIEI 'NATCHEZ'	'NATCHEZ' CRAPE MYRTLE		8-10'	B&B	8	CM
DRNUS KOUSA	KOUSA DOGWOOD		5-7′	B&B	4	DW
IRUBS						
MANTHUS FRAGRANS	FRAGRANT TEA OLIVE			7 GAL.	15	TO
ROPETALUM CHINENSE VAR. RUBRUM 'RUBY'	RUBY RED LORAPETALUM			3 GAL.	33	L-RR
SUSTRUM JAPONICUM 'RECURVIFOLIUM'	LIGUSTRUM RECURVIFOLIUM			5 GAL	8	LR
EX CORNUTA 'CARISSA'	CARISSA HOLLY			3 GAL	41	CH
EX 'CONAF' OAKLEAF	OAKLEAF HOLLY			25 GAL.	11	OH
NNISETUM ALOPECUROIDES 'HAMELN'	DWARF FOUNTAIN GRASS			1 GAL.	48	DFG
SCANTHUS SINENSIS 'ADAGIO'	ADAGIO MAIDEN GRASS			3 GAL.	21	MS
RBERIS THUNBERGII 'CRIMSON PYGMY' ('ATROPURPUREA NANA')	CRIMSON PYGMY DWARF BARBERRY			3 GAL.	12	BAR
MANDRA LONGIFOLIA 'KATRINUS DELUXE' TM	LOMANDRA 'KATRINUS DELUXE TM'			1 GAL.	42	LOM
RICA CERIFERA	WAX MYRTLE			7 GAL.	19	WM
EX X 'NELLIE R. STEVENS'	NELLIE R. STEVENS HOLLY			15 GAL.	14	NRS
RIUM OLEANDER 'PINK'	PINK OLEANDER			7 GAL.	10	NO
TOSPORUM TOBIRA 'COMPACTA'	PITTOSPORUM COMPACTA			7 GAL.	28	PIT
ROUNDCOVER						
RIOPE MUSCARI 'VARIEGATA'	VARIEGATED LIRIOPE		1 QT.	18" O.C.	138	
DBEKIA FULGIDA	ORANGE CONEFLOWER		1 QT.	24″ O.C.	37	
DREKTY FORDY	URANGE CONEFLOWER		1 11.	24″ O.C.	/ك	-

LANDSCAPING PARKING ISLANDS

ISLAND	AREA (SF)	REQUIRED TREES	PROVIDED	SHADE PROVIDED
1	427	1 canopy	1 canopy/ 1 small shade	1,021 SF
2	248	1 small shade	1 canopy	707 SF
3	411	1 small shade	1 canopy	707 SF
4	1,273	3 canopy	3 canopy	2,121 SF
5	498	1 canopy	1 canopy	707 SF
6	344	1 small shade	1 canopy	707 SF
7	221	1 small shade	1 canopy	707 SF
8	616	1 canopy	1 canopy, 1 small shade	1,021 SF
9	711	1 canopy, 1 small shade	1 canopy/ 1 small shade	1,021 SF

<u>Section 18-481 (a)</u> All single planting islands measuring twelve (12) feet by eighteen (18) feet or **216** SF shall have at least one (1) tree. All double planting islands measuring twelve (12) feet by thirty-six (36) feet or **432** SF shall have at least two (2) small mature shade trees or one canopy tree.

LANDSCAPE SCHEDULE

BOTANICAL NAME	COMMON NAME	CAL.	нт.	REMARKS	QUAN.	SYMBOL
LARGE SHADE TREES						
QUERCUS VIRGINIANA	LIVE OAK	2.5″		B&B	5	LO
PISTACIA CHINENSIS	CHINESE PISTACHE	2.5″		B&B	4	СР
KOELREUTERIA PANICULATA	GOLDEN RAIN TREE	2.5″		B&B	2	GR
QUERCUS PHELLOS	WILLOW OAK	2.5″		B&B	2	W0
SMALL SHADE TREES						
LAGERSTROEMIA INDICA X FAURIEI 'NATCHEZ'	'NATCHEZ' CRAPE MYRTLE		8-10'	B&B	8	CM
CORNUS KOUSA	KOUSA DOGWOOD		5-7′	B&B	4	DW
OLIDUDO						
SHRUBS OSMANTHUS FRAGRANS	 FRAGRANT TEA OLIVE			7 GAL.	15	TO
LOROPETALUM CHINENSE VAR. RUBRUM 'RUBY'	RUBY RED LORAPETALUM			3 GAL.	33	L-RR
LIGUSTRUM JAPONICUM 'RECURVIFOLIUM'	LIGUSTRUM RECURVIFOLIUM			5 GAL.	8	LR
ILEX CORNUTA 'CARISSA'	CARISSA HOLLY			3 GAL	41	CH
ILEX 'CONAF' OAKLEAF	OAKLEAF HOLLY			25 GAL.	11	OH
PENNISETUM ALOPECUROIDES 'HAMELN'	DWARF FOUNTAIN GRASS			1 GAL.	48	DFG
MISCANTHUS SINENSIS 'ADAGIO'	ADAGIO MAIDEN GRASS			3 GAL.	21	MS
BERBERIS THUNBERGII 'CRIMSON PYGMY' ('ATROPURPUREA NANA')				3 GAL.	12	BAR
LOMANDRA LONGIFOLIA 'KATRINUS DELUXE' TM	LOMANDRA 'KATRINUS DELUXE TM'			1 GAL.	42	LOM
MYRICA CERIFERA	WAX MYRTLE			7 GAL.	19	WM
ILEX X 'NELLIE R. STEVENS'	NELLIE R. STEVENS HOLLY			15 GAL.	14	NRS
NERIUM OLEANDER 'PINK'	PINK OLEANDER			7 GAL.	10	NO
PITTOSPORUM TOBIRA 'COMPACTA'	PITTOSPORUM COMPACTA			7 GAL.	28	PIT
GROUNDCOVER						
LIRIOPE MUSCARI 'VARIEGATA'	VARIEGATED LIRIOPE		1 QT.	18″ O.C.	138	
RUDBEKIA FULGIDA	ORANGE CONEFLOWER		1 QT.	24″ O.C.	37	
SOD	EMPIRE ZOYSIA					

PARKING LOT LANDSCAPE NOTES:

Public Services Engineering Division APPROVED STORMWATER MANAGEMENT PLAN

WILMINGTON

Approved Construction Plan

<u>Nam</u>e

| Date:_____ Permit #_____ Signed: _____

LANDSCAPE NOTES

RESPONSIBILITY OF THE CONTRACTOR.

PART OF THE S&E PLANS.

PRUNNING WITHIN LIMITS

PEST CONTROL (OPTIONAL)

INSTALLATION OF THE PLANTS.

PROTECTION OF ROOT ZONES

PROTECTED TREE REGULATION

For each open

utlity cut of

City streets, a \$325

permit shall be required

from the

occupancy

and/or project

acceptance.

Plann<u>ing</u>

Tr<u>affic</u>

City prior to

H. STAKE AT WIRE REMOVAL

WATERING SCHEDULE FOR IRRIGATION SYSTEM

TREES SHRUBS AND GRASSED AREAS

THOROUGH WATERING IS REQUIRED UPON COMPLETION.

FERTILIZATION

MULCHING

MOWING

1. ALL LANDSCAPE MATERIAL MUST BE INSTALLED PRIOR TO FINAL BUILDING INSPECTION

VERIFICATION OF TOTAL QUANTITIES AS SHOWN IN THE PLANT LIST SHALL BE THE

AREAS TO ALLOW VEHICLE OVERHANG WHEN PARKING STOPS ARE NOT REQUIRED.

8. ALL PLANTINGS USED TO SCREEN THE DRIVES AND PARKING AREAS FROM ADJOINING

ROADWAYS WILL NEED TO BE A MINIMUM OF 24" HIGH AT TIME OF PLANTING.

10. THE OWNERS OF THE PROPERTY AND THEIR AGENTS, HEIRS, OR ASSIGNS SHALL BE

ANNUAL MAINTENANCE OF THE VEGETATION TO INCLUDE BUT NOT BE LIMITED TO:

WITHOUT PRIOR APPROVAL OF THE LANDSCAPE ARCHITECT.

THE CONTRACTOR SHALL BE RESPONSIBLE FOR THE LOCATION AND/OR RELOCATION OF

3. CONTRACTOR SHALL NOT SUBSTITUTE FOR ANY OF THE PLANT MATERIAL THAT IS SPECIFIED

5. MULCH UNDER ALL PROPOSED TREES AND SHRUBS WITH PINE NEEDLES AT A 3"-4" DEPTH OR

6. PLANT SIZES INDICATED SPECIFY MINIMUM ALLOWABLE SIZES AT PLANTING. WHERE CONTAINER AND HT. SIZES ARE INDICATED FOR A SINGLE SPECIES, BOTH SIZE REQUIREMENTS MUST BE

9. ALL OTHER AREAS NOT BEING MULCHED TO BE SEEDED PER SEEDING SCHEDULE INCLUDED AS

RESPONSIBLE FOR THE INSTALLATION, PRESERVATION AND MAINTENANCE OF ALL PLANTING AND PHYSICAL FEATURES SHOWN ON THIS PLAN. THE OWNERS SHALL BE RESPONSIBLE FOR

BROADCAST A SLOW RELEASE FERTILIZER OVER THE MULCHED BEDS AT THE RECOMMENDED

PRUNING WHEN NECESSARY, WILL BE DONE TO MAINTAIN THEIR NORMAL GROWTH PATTERN

AND TO REMOVE DEAD OR DISEASED PLANT MATERIAL. THERE SHALL BE NO TOPPING OF

WEED CONTROL TO BE PROVIDED EARY FEBRUARY, APRIL, JUNE, AUGUST AND OCTOBER IN THE SHRUB/TREE BEDS AND IN THE LAWN AREAS. INSECT DAMAGE SHALL BE TREATED WHEN NECESSARY TO PREVENT DAMAGE TO VEGETATION.

RE-MULCHED SO THAT THEY CONTAIN A MIN. DEPTH OF TWO INCHES AND A MAXIMUM DEPTH

MOWING SHALL BE DONE AS NECESSARY TO KEEP GRASS AT THE APPROPRIATE HEIGHT TO

TREE/SHRUB ROOT ZONES SHOULD BE PROTECTED FROM FUTURE CONSTRUCTION AND EQUIPMENT AS MUCH AS POSSIBLE TO AVOID DAMAGE OR COMPACTION TO THE ROOT AREAS.

MAINTENANCE SHALL INCLUDE A THOROUGH INITIAL WATERING WITH WEEKLY WATERINGS THEREAFTER FOR THE FIRST 30 DAYS. WATERINGS THEREAFTER BE ON AN AS NEEDED SCHEDULE PER LOCAL CONDITIONS.

AT THE END OF THE FIRST YEAR ALL PLANT STAKING AND GUYING SYSTEMS SHALL BE

PRIOR TO ANY CLEARING, GRADING OR CONSTRUCTION ACTIVITY, TREE PROTECTION FENCING WILL BE INSTALLED AROUND PROTECTED TREES OR GROVES OF TREES AND NO CONSTRUCTION WORKERS, TOOLS, MATERIALS OR VEHICLES ARE PERMITTED WITHIN THE TREE PROTECTION


RATES AS SHOWN ON THE BAGS, ONCE MID-FEBRUARY AND ONCE MID-SEPTEMBER.


ALL AREAS AROUND THE BUILDING FOUNDATION AND SHRUB/TREE BEDS SHALL BE

OF THREE INCHES. MULCH USED SHALL EQUAL WHICH WAS SUPPLIED DURING THE

THERE SHALL BE AT LEAST A 3 FT. SEPARATION BETWEEN LANDSCAPED AREAS AND PARKING

EXISTING UTILITIES IN COORDINATION WITH THE APPROPRIATE UTILITY AGENCY OR COMPANY.

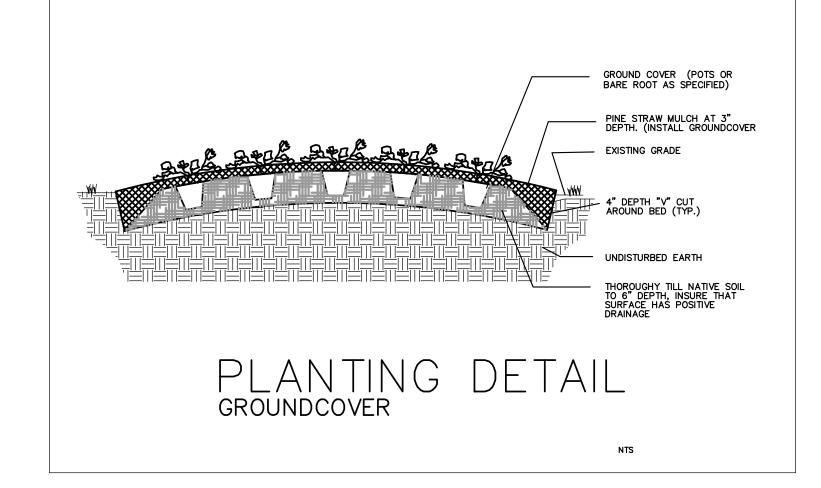

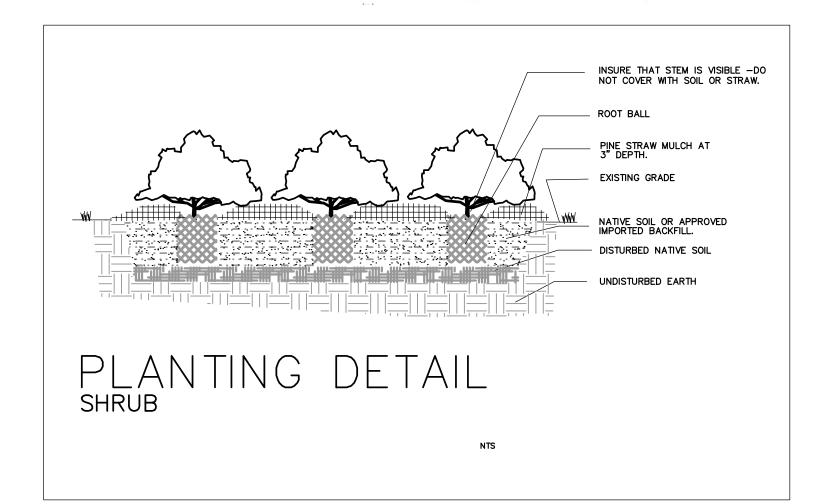

STREET YARD CALCULATIONS

STREET YARD (S.Y.) = 670 LF - 30 LF (DRIVEWAY) = 640 LFREQUIRED S.Y. AREA = 7,680 [640 LF \times 12 (MULTIPLIER)] PROVIDED S.Y. AREA = 8,548

REQUIRED TREES @ 1/600 SF = 13 TREES PROPOSED TREES = 7 NEW TREES + (CREDIT 6 EX. CANOPY TREES) REQUIRED SHRUBS @ 6/600 SF = 77 SHRUBS PROPOSED SHRUBS = 91

ALL PROPOSED VEGETATION WITHIN SITE TRIANGLES SHALL NOT INTERFERE WITH CLEAR VISUAL SIGHT LINES FROM 30" - 10' [SEC.18-566 COW]

PARKING INTERIOR AREA CALCULATIONS

8% of TOTAL PARKING AREA PARKING LOT AREA = 23,586 SF REQUIRED VEGETATED AREA = 1,886 SF PROPOSED VEGETATED AREA = 5,606 SF

PARKING AREA SCREENING

PARKING WITHIN 50' OF A R.O.W. REQUIRES A LOW SCREEN MIN. 3' HIGH AND 5' WIDE

* SCREENING INCLUDED IN STREETYARD PLANTING

PARKING AREA SHADING

20% SHADE REQ'D AT MATURITY PARKING LOT AREA=..... SHADING AREA REQ'D=.... 4,717 SF SHADING AREA PROVIDED=......8,719 SF (SEE PARKING ISLAND TABLE)

FOUNDATION PLANTING AREAS

REQUIREMENT: FACADE AREA X 12% BUILDING HEIGHT = 25 FT BUILDING WIDTH (LF) = 567 LF REQ'D FOUNDATION LANDSCAPING = 1,701 SF PROVIDED = 2,687 SF

Tree Name	# of Trees	DBH	% Mitigation	Total DB
Magnolia	1	8"	100	16
Magnolia	1	12"	100	24
Loblolly Pine	1	33"	50	33
Maple	1	24"	25	12
Total DBH of Re	moved rees	Significant	=	85"
Total Trees Req. for Mitigation	=	Total DBH X	2X mitigation %	= 28

Sec. 18-460 Mitigation: Significant trees . The total number of replacement trees shall be determined by multiplying the total DBH of the removed significant trees by two (2) times the percentage for the type of tree in Table IV and dividing by three

12 12 100 100 10 100 100 100 15 100 18 100 100 10 10 Magnolia 22 100 Magnolia **Loblolly Pine** 12 **Loblolly Pine** 24 Loblolly Pine 28 22.5 10 11 16.5 10.5 14 192 12 N/A 13 N/A 112 N/A

Proposed Regulated Trees to be Removed

Trees

% Mitigation

NOT FOR

CONSTRUCTION

Pine	3	20	N/A	60
Total DBH of Rem	oved Regu	ulated Trees		1048.5
Total Trees Req. for Mitigation	=	Total DBH)	C mitigation %	= 350

15

16

17

18

19

N/A

N/A

N/A

N/A


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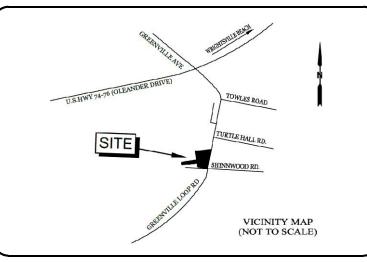
Sec. 18-460 Mitigation: Regulated trees . The total number of replacement trees shall be determined for regulated trees removed by multiplying the total DBH of the removed regulated tree(s) by the percentage for the type of tree in Table IV and dividing by three (3).

Section 18-461 Exceptions to Mitigation: (b) Regulated trees removed within the area of disturbance necessary for essential site improvements are exempt from mitigation, provided the applicant has designed around trees in order to retain as many trees as practicable.

Credit for Preserved Trees (Sec. 18-448 Table 1)					
# of Preserved Trees	Size (DBH)	Credit Given	Resulting Credit		
5	2-5"	1	5		
51	6-11"	2	102		
62	12-17"	3	186		
14	18-23"	4	56		
18	>24"	= (DBH/6)	84		


Total resulting Credit for 433 **150 Preserved Trees**



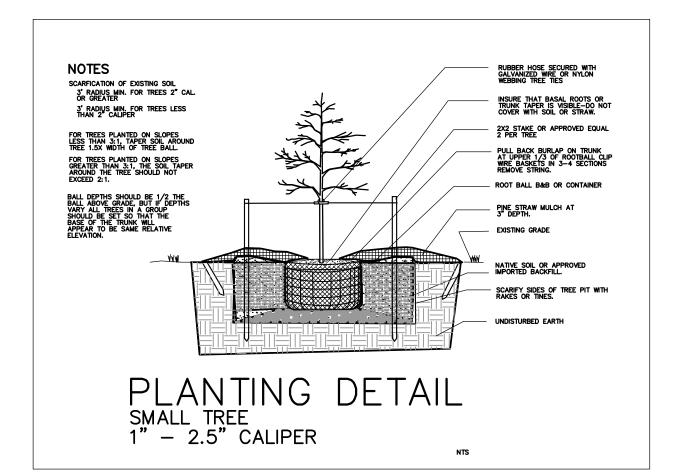

LEGEND:


ENGINEER:

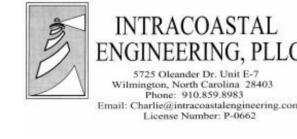

DESCRIPTION DATE

CLIENT INFO: SKF ILM, LLC 5929 MARKET ST. WILMINGTON, NC 28405 (910) - 619 - 6858

REVISIONS

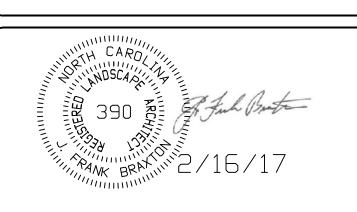

★ FOR LANDSCAPE ONLY

LANDSCAPE ARCHITECT:

Coastal Land Design, PLLC Civil Engineering / Landscape Architecture Land Planning / Construction Management NCBELS Firm License No: P-0369

P.O.Box 1172 Phone: 910-254-9333 Wilmington, NC 28402 www.cldeng.com Fax: 910-254-0502

DRAWN:	N ALLEN	PROJECT	
DESIGN:	J CARMINE	NUMBER :	
CHECK :	F BRAXTON	SCALE :	1"=20'
APPROVED :	J PETROFF	DATE :	10 AUGUST 201

SHINWOOD COTTAGES

LANDSCAPE PLAN/ **DETAILS**

L-2